
# CTS STANDARD DESIGN -BOOK OF DRAWINGS

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AMENDMENTS			
No Date Revision		Revision	

- ALL DIMENSIONS TO BE CHECKED ON SITE, WRITTEN DIMENSIONS TO BE FOLLOWED IN PREFERENCE TO SCALED DIMENSIONS
- ALL WALLS LESS THAN 200MM THICK TO BE REINFORCED WITH HOOF IRON AT EVERY ALTERNATE COURSE.
- ALL REINFORCED CONCRETE WORK IS TO BE IN ACCORDANCE WITH STRUCTURAL ENGINEER'S DETAILS.
- ALL SANITARY WORK TO BE IN ACCORDANCE WITH M.O.H RULES AND REGULATIONS.
- WHERE DRAIN PASSES UNDER BUILDING OR DRIVEWAY AREA. PIPE TO BE OF CAST IRON OR ENCASED IN 150MM CONCRETE.
- ALL WASTE PIPES AND SOIL PIPES ARE TO BE IN DUCTS AND THE BEND TO HAVE ALL CLEANING EYES ACCESSIBLE FROM OUTSIDE.
- ALL WINDOWS AND EXTERNAL GLAZED DOORS ON GROUND FLOOR TO HAVE BURGLAR PROOFING TO DETAILS.
- ALL INTERNAL PLASTER TO BE TWO COATS STEEL FLOAT FINISHED.
- PROVIDE G.I. 125 x 100 RAINWATER DOWN PIPES AND
- 125 x 100 G.I.BOX GUTTER WITH BRACKETS ETC. WHERE SHOWN.
- 11. ALL PAINTING TO BE 3 COATS.
- 12. SPLASH APRON OF 600MM ALONG THE PERIMETER OF BUILDING.
- 13. SAMPLES OF FITTINGS, MATERIALS ETC. TO BE PRODUCED & APPROV
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- 16. THE ENGINEER SHALL NOT ACCEPT ANY LIABILITY FOR WORKS WHICH HE HAS NOT BEEN EXPRESSLY INSTRUCTED TO SUPERVISE IN WRITING AND HAS ACCEPTED TO PROCEED IN WRITING, OR FOR ANY OMISSIONS OR DEVIATIONS FROM HIS DRAWINGS/TECHNICAL SPECIFICATIONS. OR DEVIATIONS FROM HIS DRAWINGS? I CEINICAL SPECIFICATIONS.
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  22. DEPTH OF FOUNDATION TRENCHES TO BE A MINIMUM OF
- 750MM BELOW REDUCED GROUND LEVEL.
- 23. ALL PIPES AND SERVICES TO BE AT A MINIMUM OF 450MM BELOW REDUCED GROUND LEVEL

### Client:

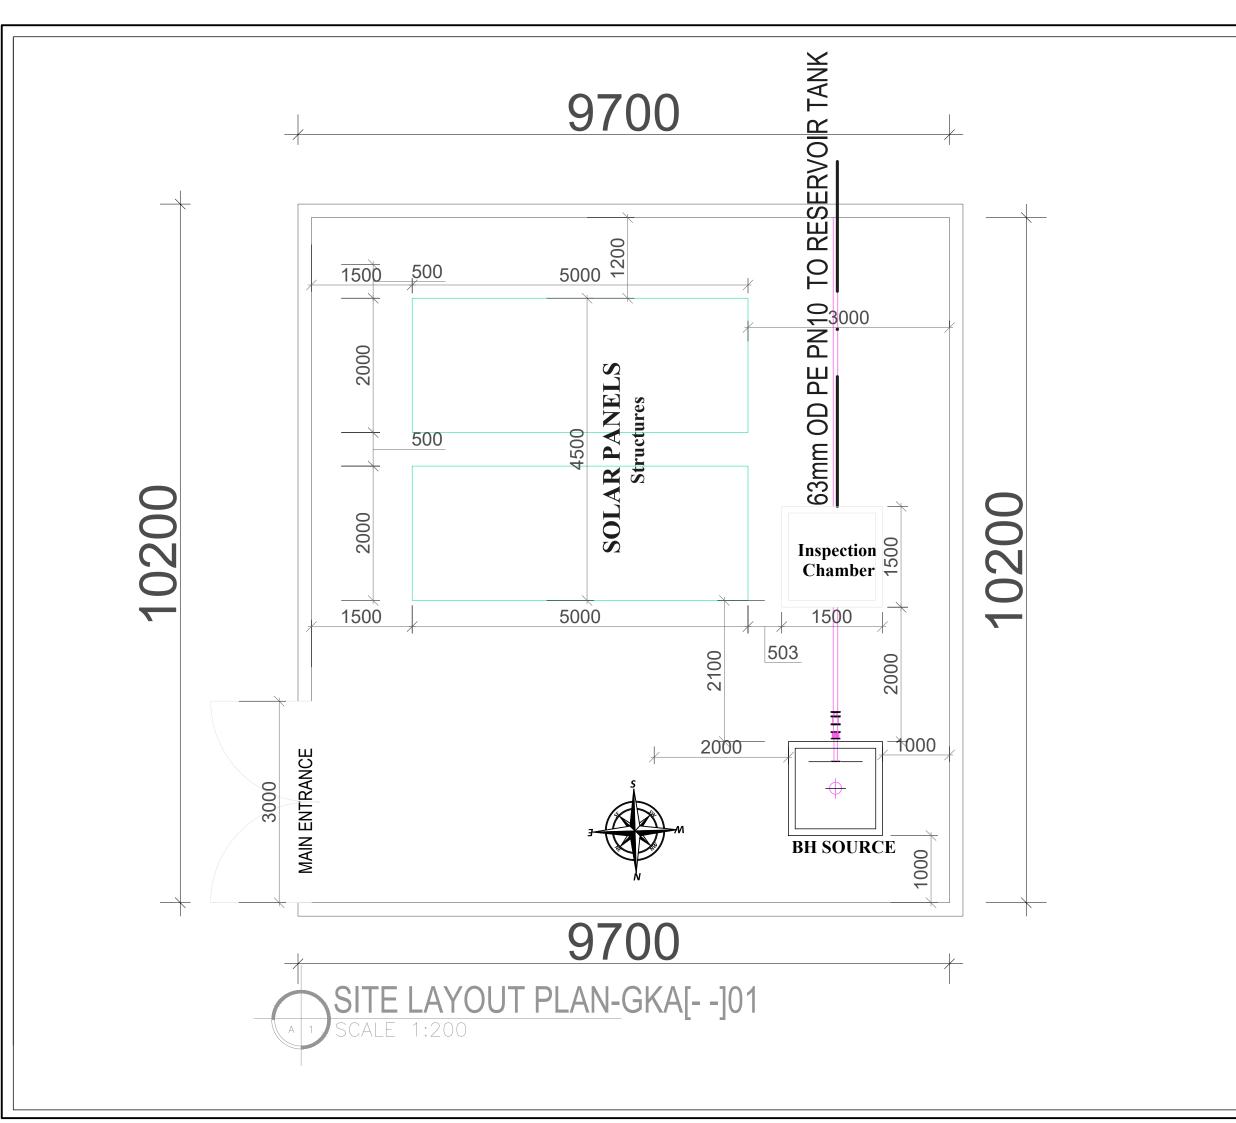

# Project:


# **COMMUNITY TAP STAND STANDARD DESIGN** FOR KAABONG DISTRICT

# Drawing Title

# Intake

Site Layout Plan

Scale:		Designed:	
AS SHOW	'N	Drawn:	PLA
Date: February/2025		Checked:	Infrastructure Team
		Approved:	JSK
Dra No:	GKA [101		

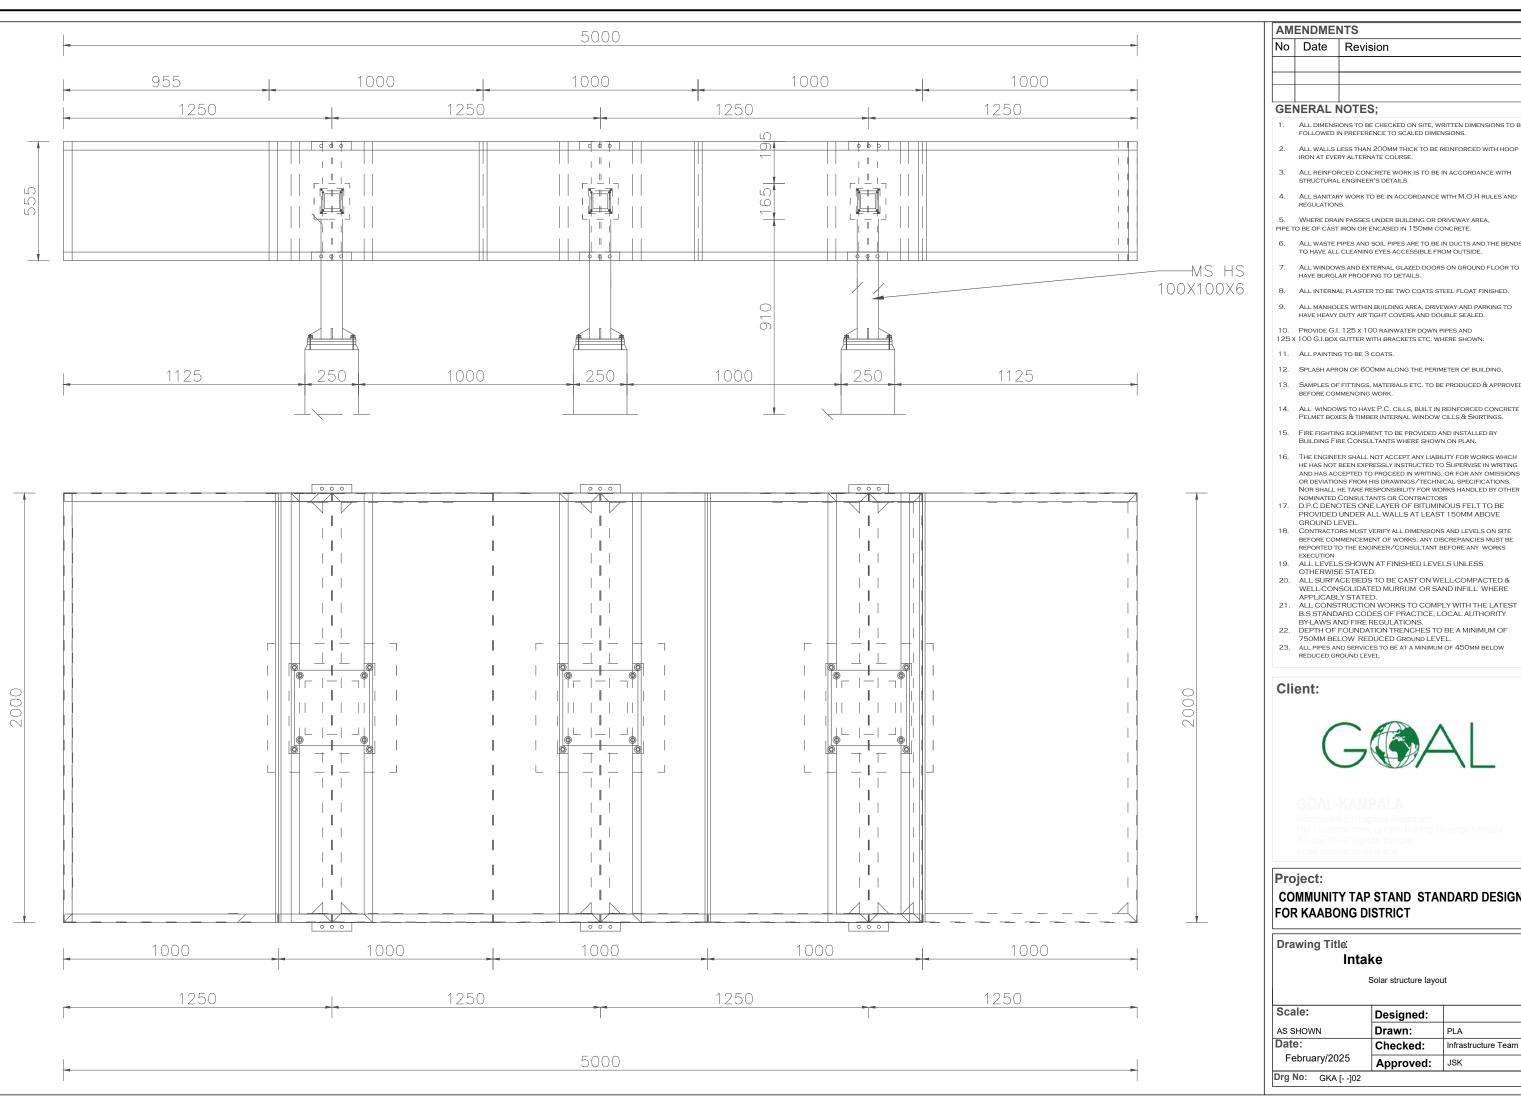

AMENDMENTS			
	No	Date	Revision

- ALL DIMENSIONS TO BE CHECKED ON SITE, WRITTEN DIMENSIONS TO BE FOLLOWED IN PREFERENCE TO SCALED DIMENSIONS
- ALL WALLS LESS THAN 200MM THICK TO BE REINFORCED WITH HOOP IRON AT EVERY ALTERNATE COURSE.
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- 5. WHERE DRAIN PASSES UNDER BUILDING OR DRIVEWAY AREA.

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- 125 x 100 G.I.BOX GUTTER WITH BRACKETS ETC. WHERE SHOWN.
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- BUILDING FIRE CONSULTANTS WHERE SHOWN ON PLAN.

- GROUND LEVEL.

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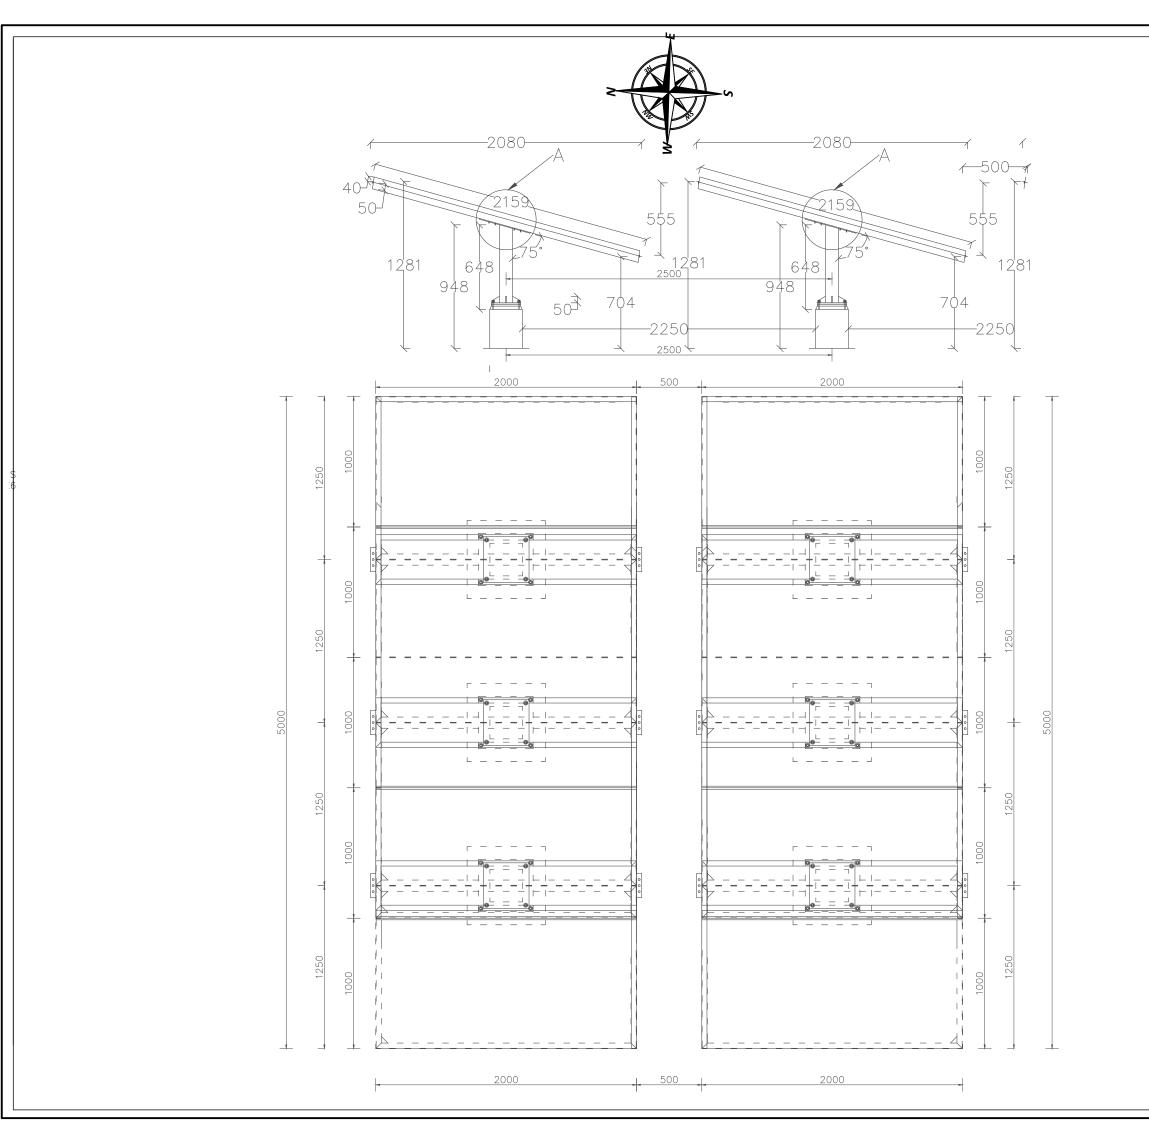
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# COMMUNITY TAP STAND STANDARD DESIGN

Solar structure layout

Scale:	Designed:	
AS SHOWN	Drawn:	PLA
Date:	Checked:	Infrastructure Team
February/2025	Approved:	JSK
Dra No: GKA [102		



# **AMENDMENTS** No Date Revision

#### **GENERAL NOTES**;

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  17. D.P.C DENOTES ONE LAYER OF BITUMINOUS FELT TO BE PROVIDED UNDER ALL WALLS AT LEAST 150MM ABOVE GROUND LEVEL.
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### Client:



# Project:


# COMMUNITY TAP STAND STANDARD DESIGN FOR KAABONG DISTRICT

# Drawing Title

#### Intake

Solar structure( Elevations and Plan)

Scale:	Designed:	
AS SHOWN	Drawn:	PLA
Date:	Checked:	Infrastructure Team
February/2025	Approved:	JSK
Drg No: GKA [103		

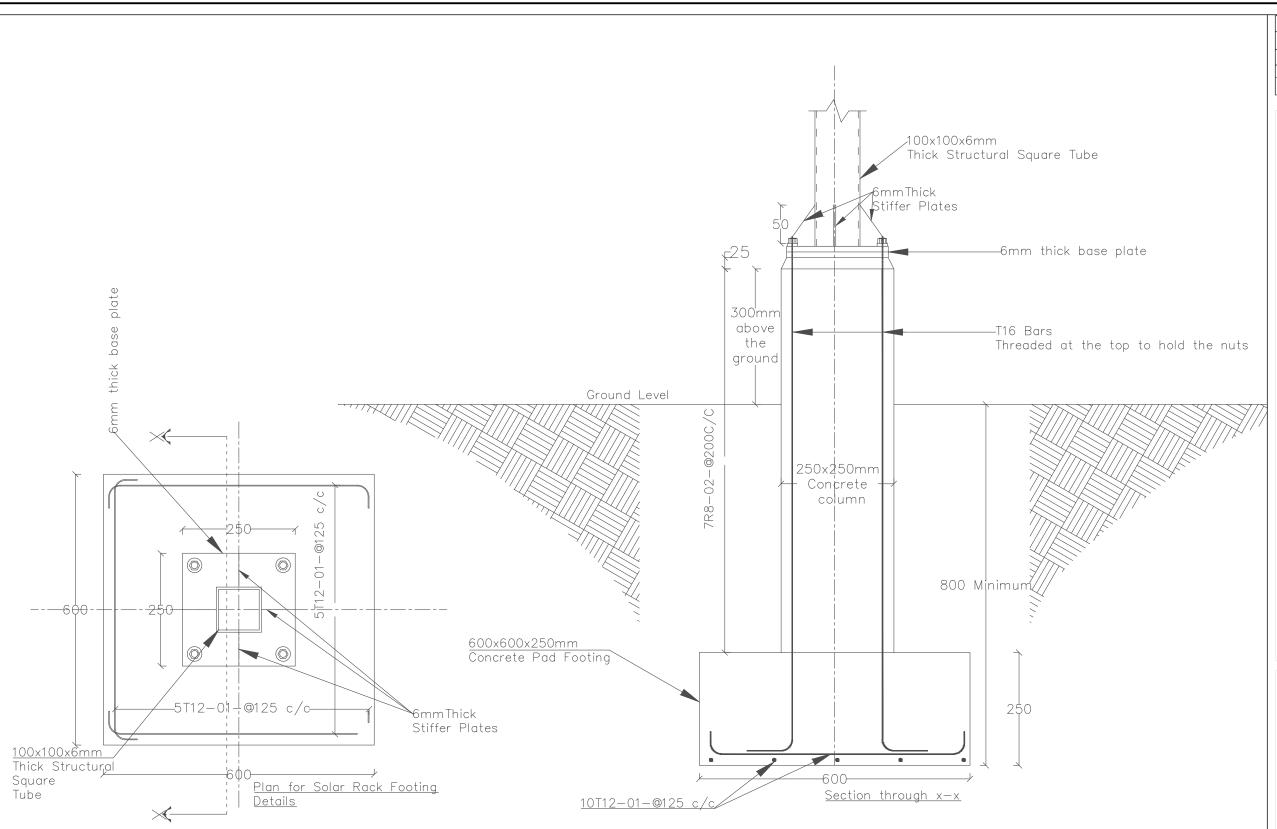

AMENDMENTS				
No Date		Revision		

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### Client:



# Project:


# COMMUNITY TAP STAND STANDARD DESIGN FOR KAABONG DISTRICT

# Drawing Title

#### Intake

Solar structure Footing details

Scale:	Designed:	
AS SHOWN	Drawn:	PLA
Date:	Checked:	Infrastructure Team
February/2025	Approved:	JSK
Drg No: GKA [104		

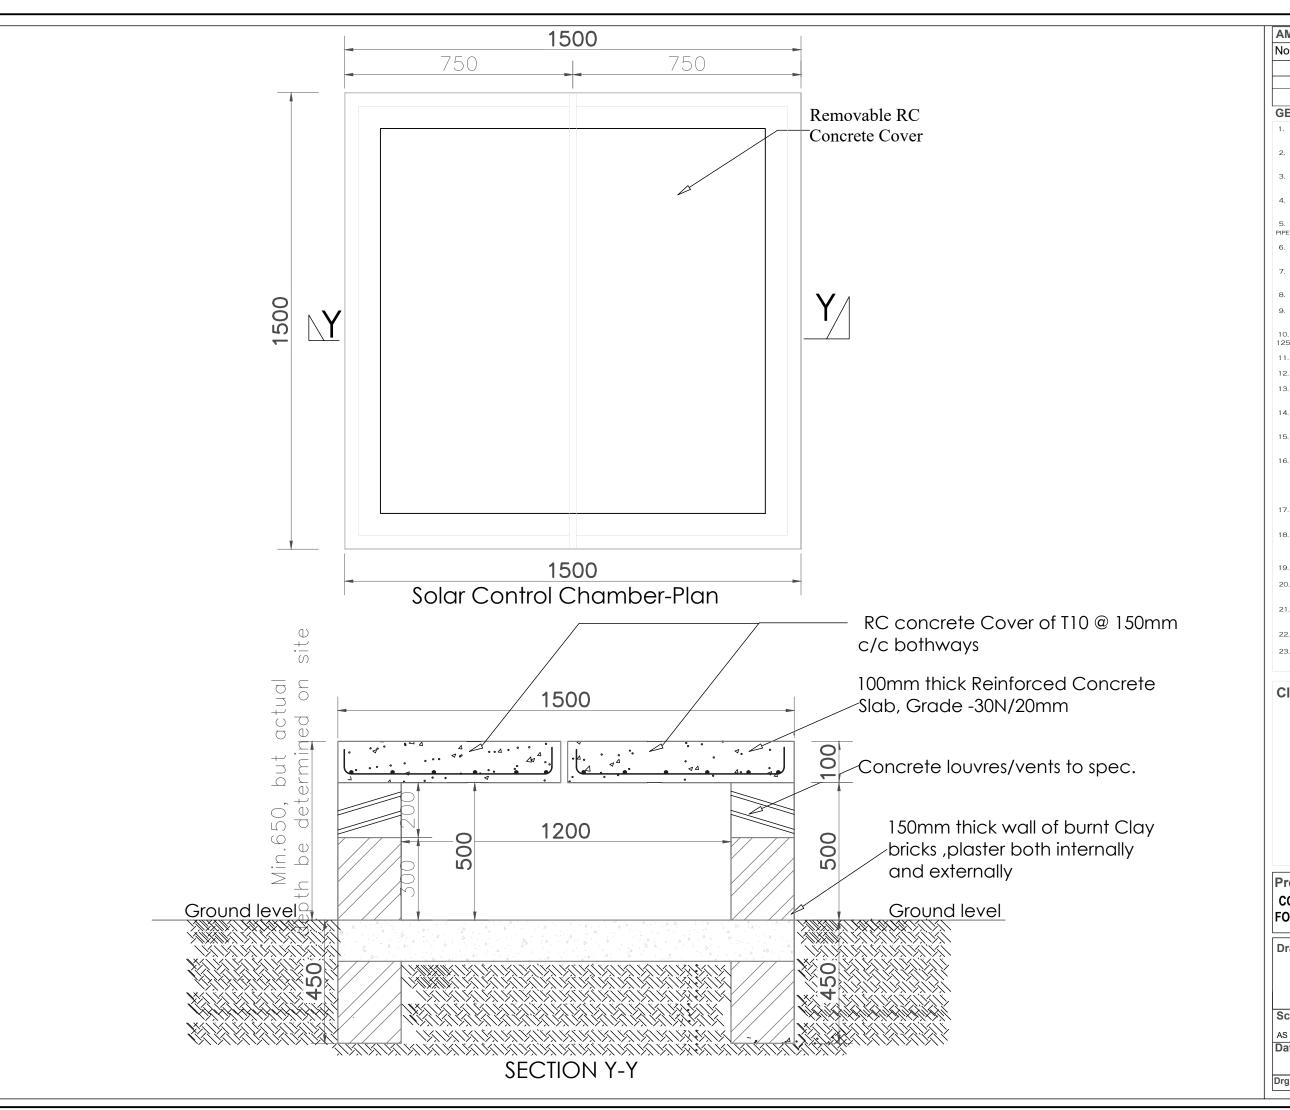

AM	AMENDMENTS				
No Date		Revision			

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### Client:



# Project:


# **COMMUNITY TAP STAND STANDARD DESIGN** FOR KAABONG DISTRICT


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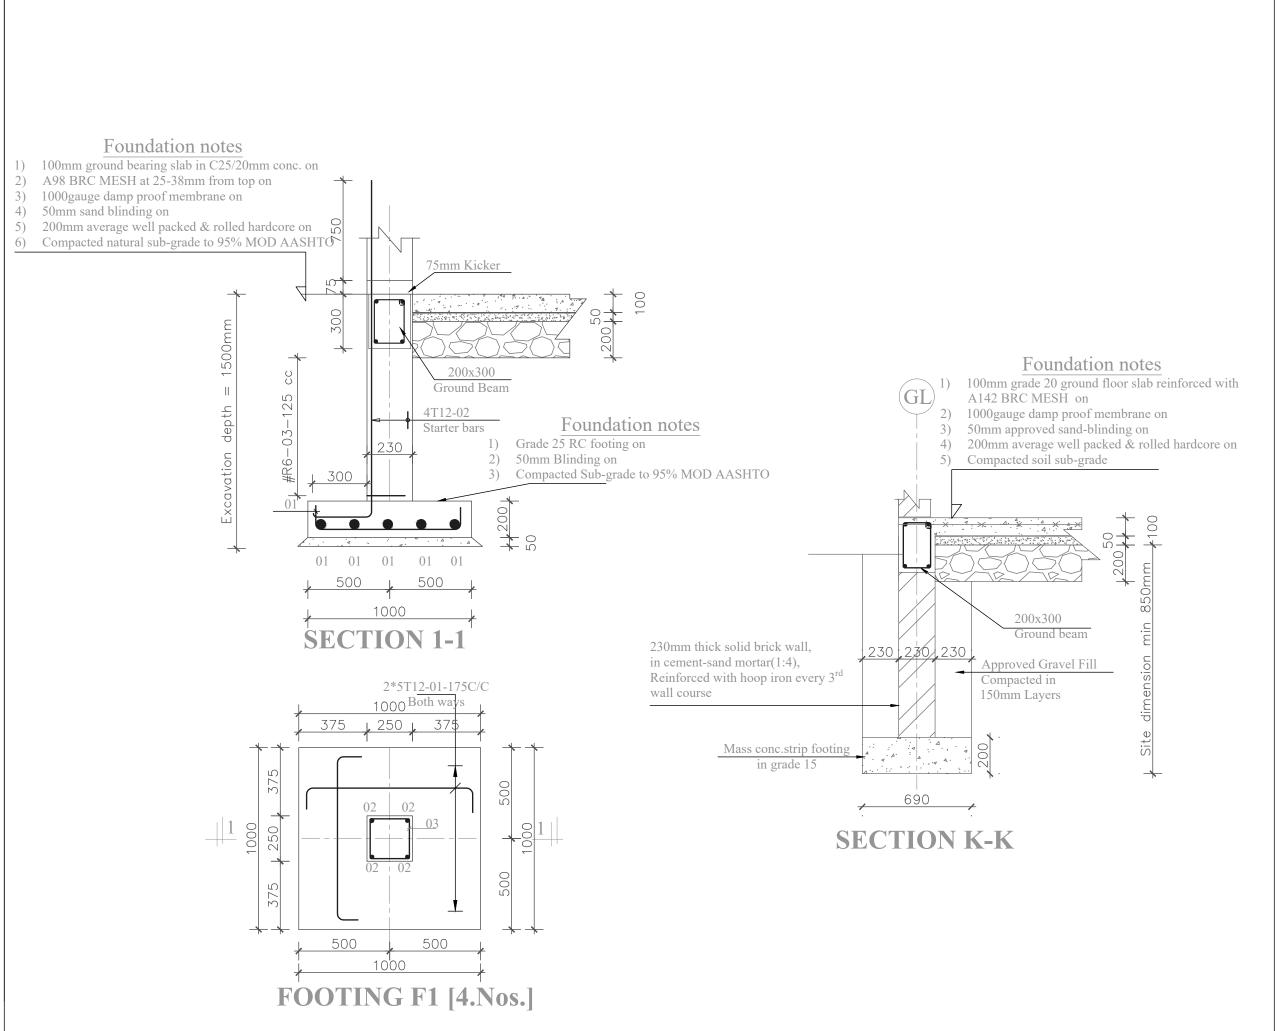
#### Intake

Inspection Chamber details

Scale:		Designed:	
	AS SHOWN	Drawn:	PLA
	Date:	Checked:	Infrastructure Team
	February/2025	Approved:	JSK
	Dra No: GKA L-105		·



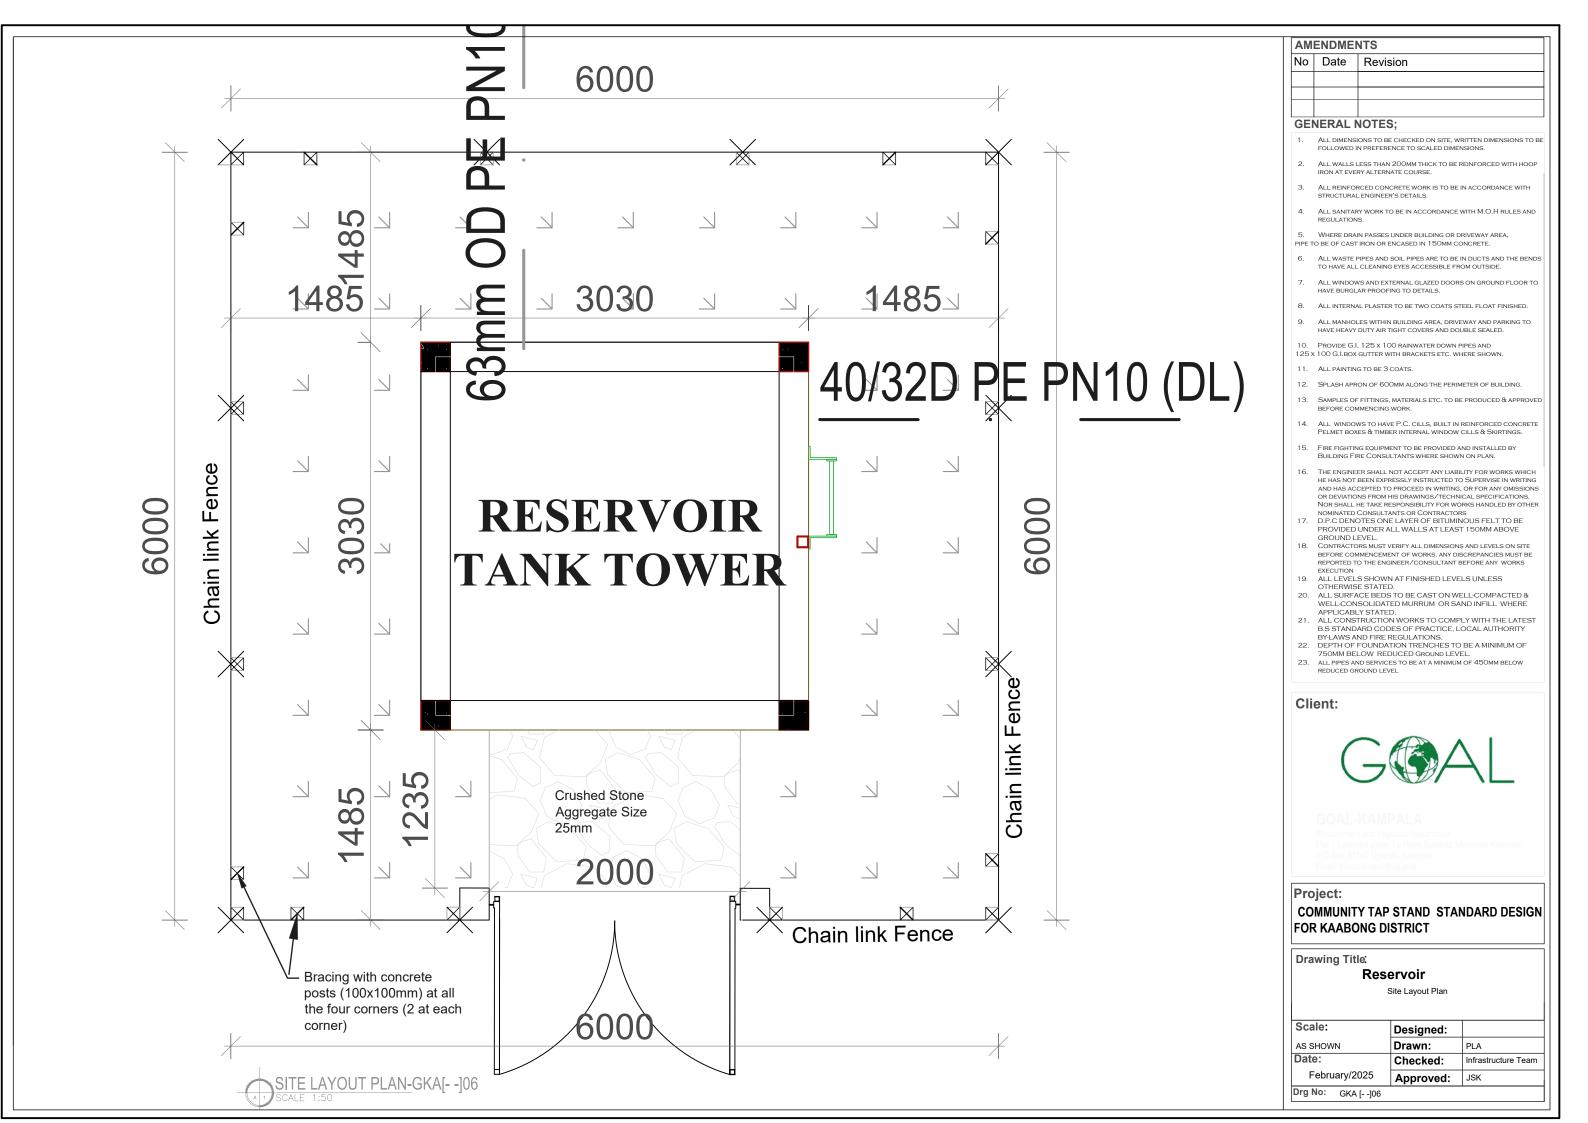

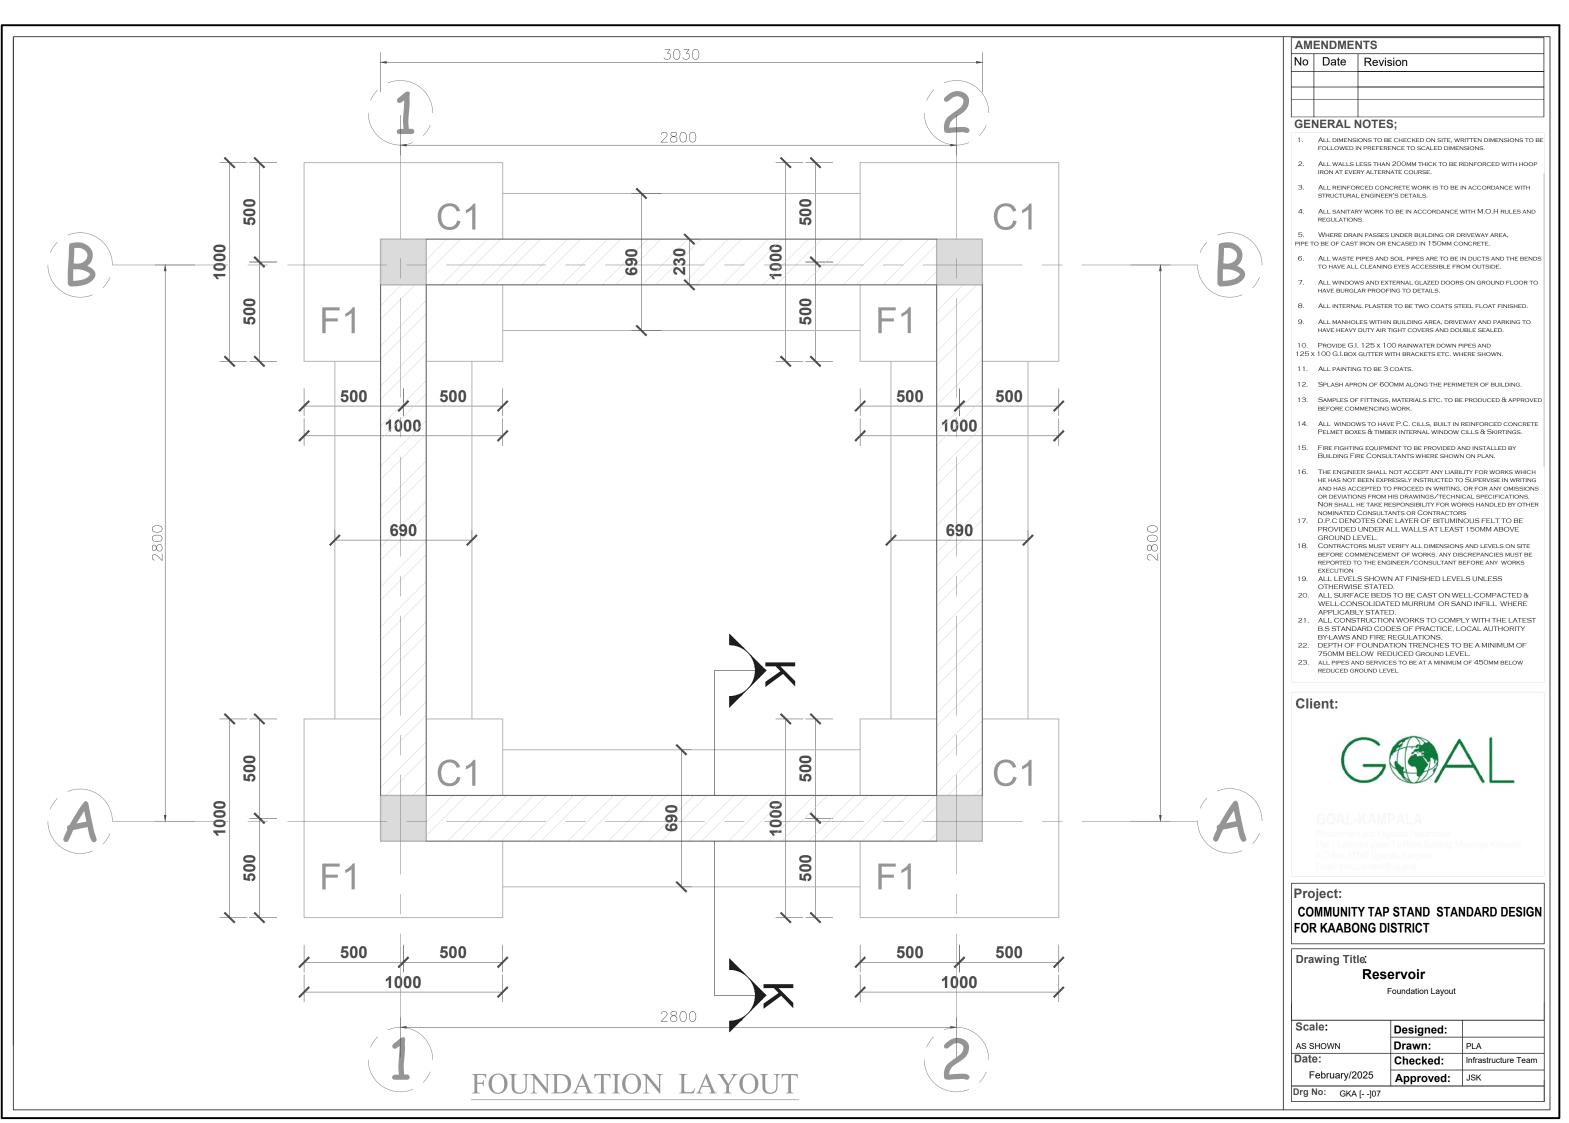

AMENDMENTS				
No Date		Revision		

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# Client:



# Project:


# COMMUNITY TAP STAND STANDARD DESIGN FOR KAABONG DISTRICT

# Drawing Title

#### Reservoir

Foundation & Column Details

Scale:	Designed:	
AS SHOWN	Drawn:	PLA
Date:	Checked:	Infrastructure Team
February/2025	Approved:	JSK
Drg No: GKA []08		

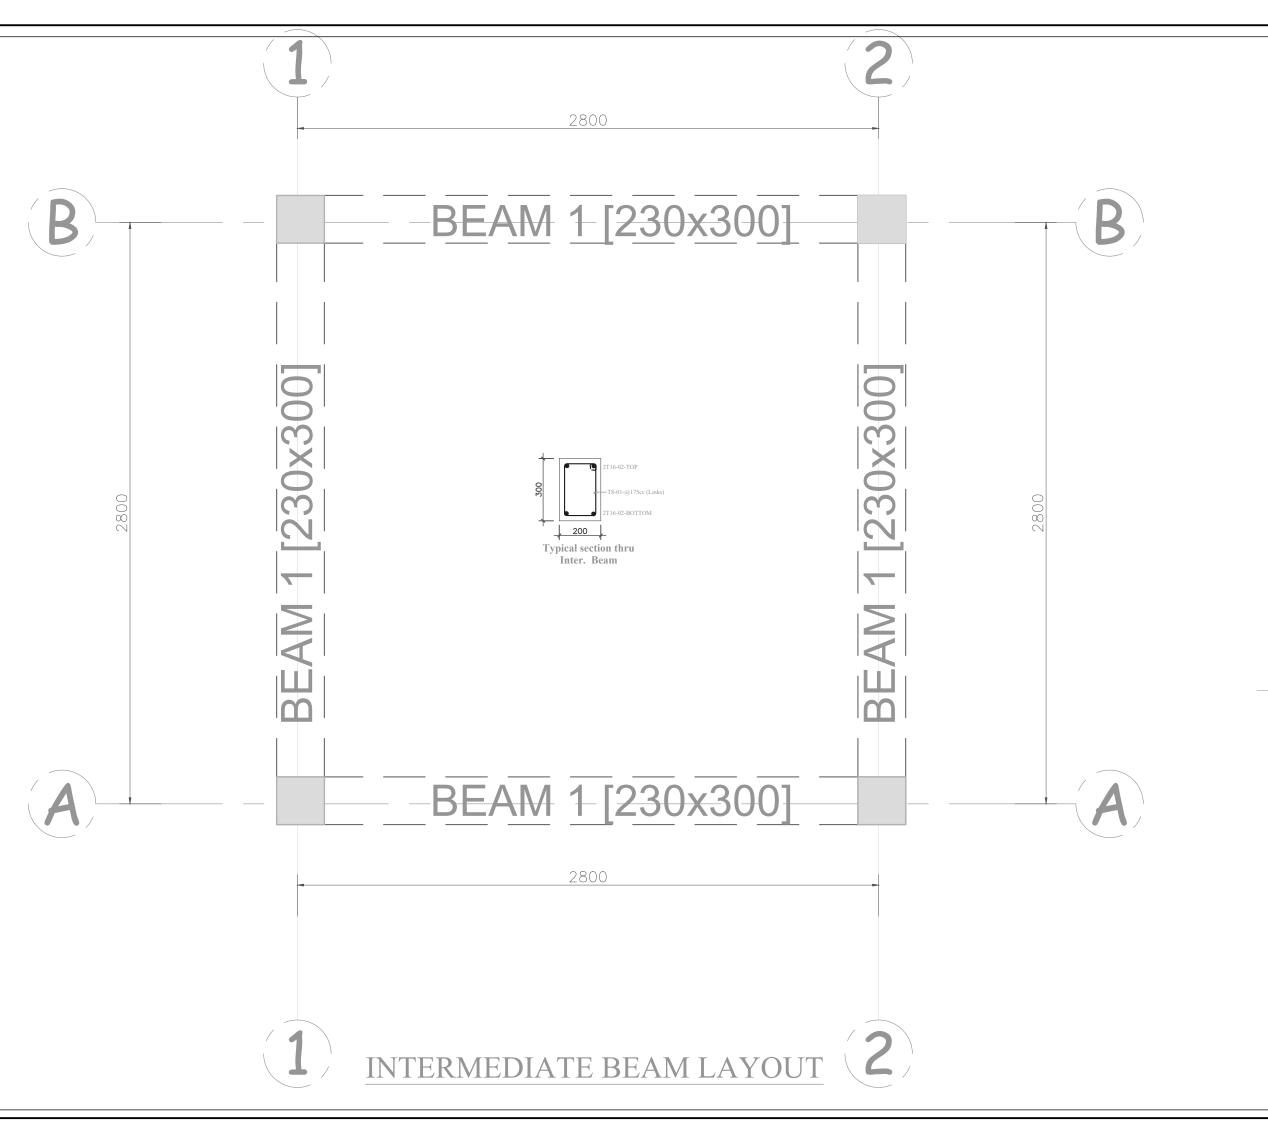

AMENDMENTS		
No	Date	Revision

- ALL DIMENSIONS TO BE CHECKED ON SITE, WRITTEN DIMENSIONS TO BE FOLLOWED IN PREFERENCE TO SCALED DIMENSION:
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### Client:



# Project:


# **COMMUNITY TAP STAND STANDARD DESIGN** FOR KAABONG DISTRICT


# Drawing Title


#### Reservoir


Intermediate Beam Layout & Details

Scale:	Designed:	
AS SHOWN	Drawn:	PLA
Date:	Checked:	Infrastructure Team
February/2025	Approved:	JSK
Drg No: GKA [109		

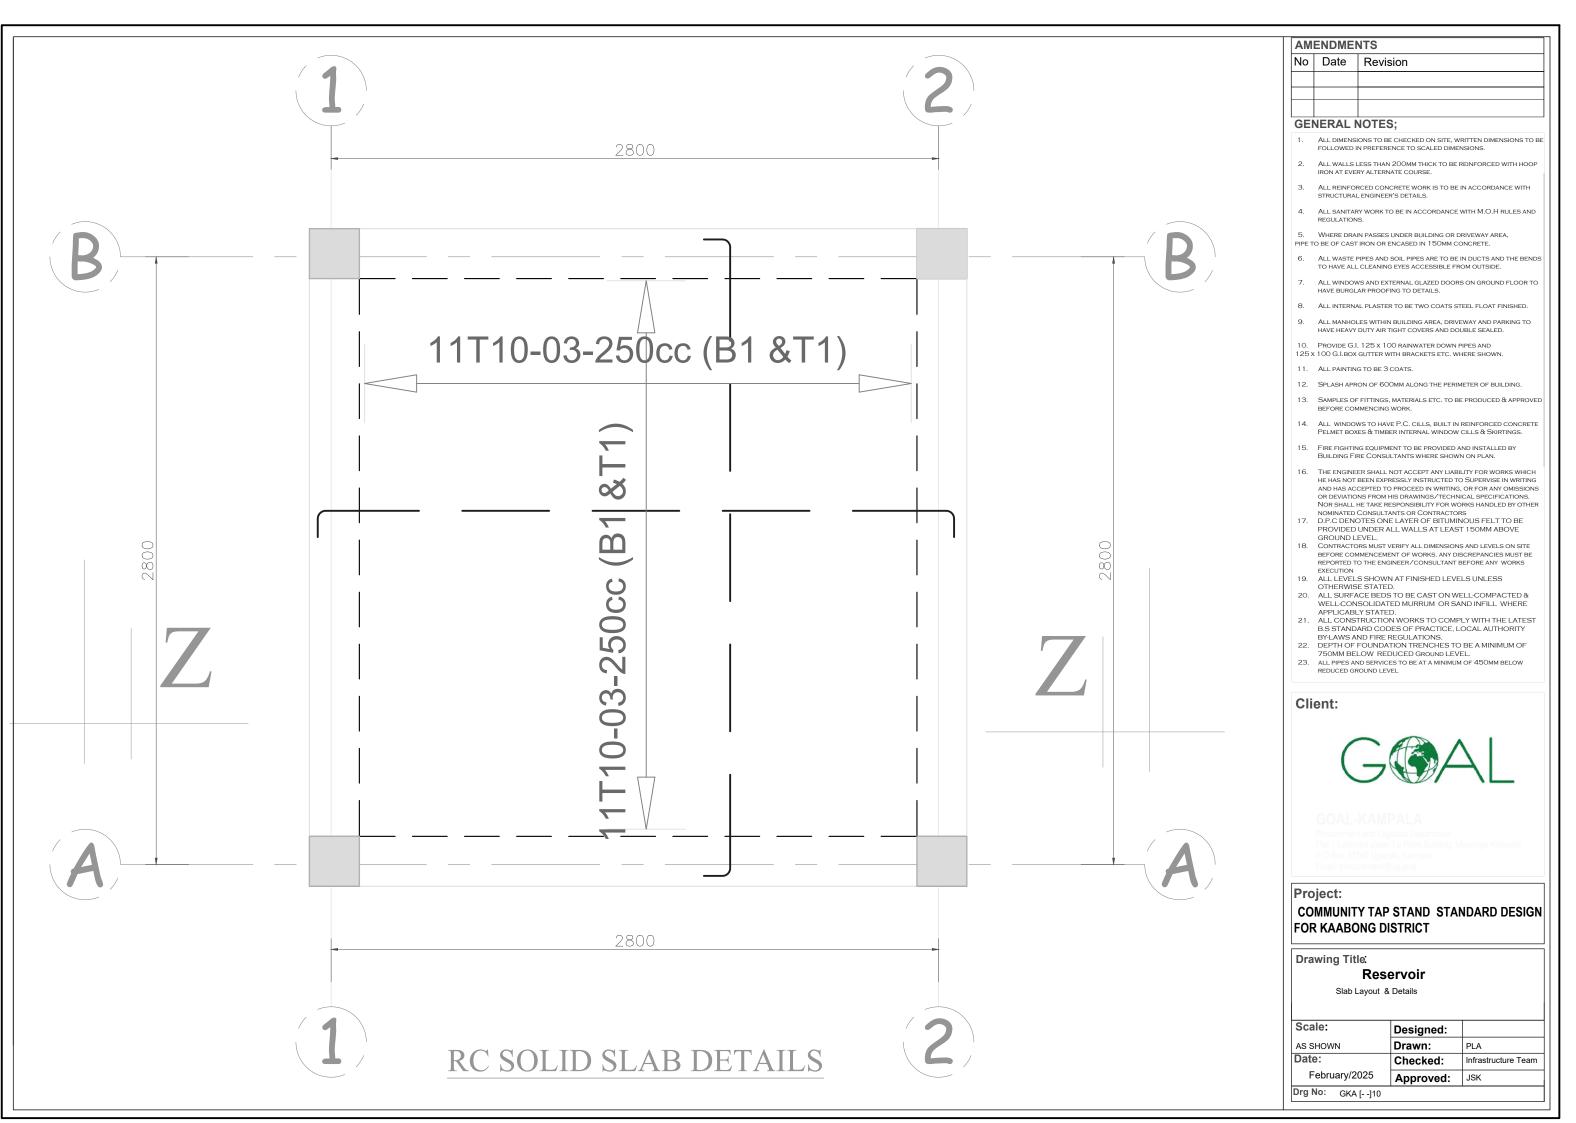

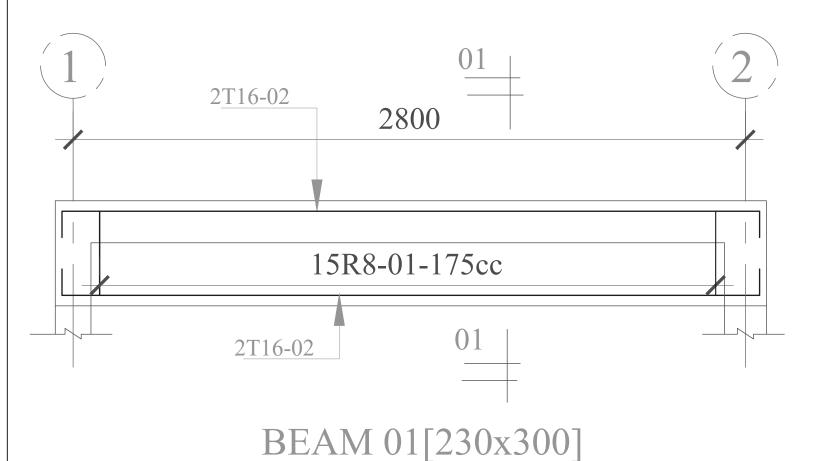

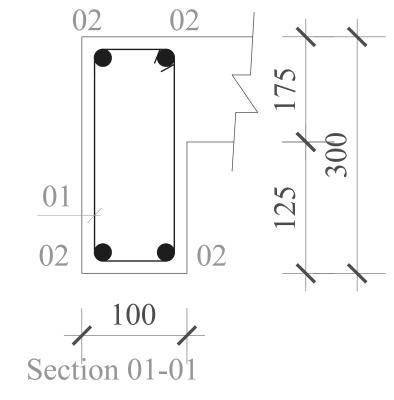

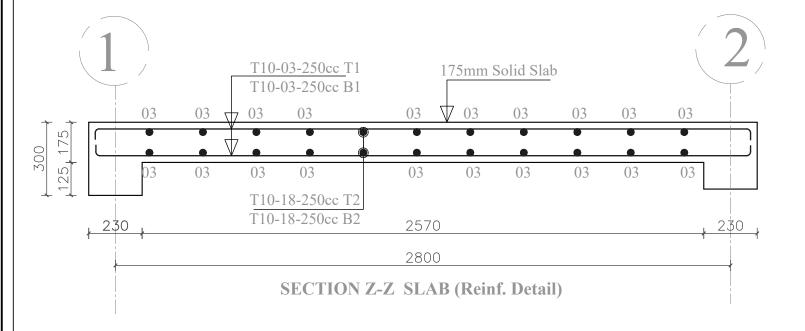

AMENDMENTS			
No	Date	Revision	

- ALL DIMENSIONS TO BE CHECKED ON SITE, WRITTEN DIMENSIONS TO BE FOLLOWED IN PREFERENCE TO SCALED DIMENSION:
- ALL WALLS LESS THAN 200MM THICK TO BE REINFORCED WITH HOOF
- ALL REINFORCED CONCRETE WORK IS TO BE IN ACCORDANCE WITH STRUCTURAL ENGINEER'S DETAILS.
- ALL SANITARY WORK TO BE IN ACCORDANCE WITH M.O.H RULES AND
- WHERE DRAIN PASSES UNDER BUILDING OR DRIVEWAY AREA.

- ALL WINDOWS AND EXTERNAL GLAZED DOORS ON GROUND FLOOR TO HAVE BURGLAR PROOFING TO DETAILS.
- ALL INTERNAL PLASTER TO BE TWO COATS STEEL FLOAT FINISHED.
- ALL MANHOLES WITHIN BUILDING AREA, DRIVEWAY AND PARKING TO HAVE HEAVY DUTY AIR TIGHT COVERS AND DOUBLE SEALED.
- PROVIDE G.I. 125 x 100 RAINWATER DOWN PIPES AND
- 125 x 100 G.I.BOX GUTTER WITH BRACKETS ETC. WHERE SHOWN.
- 11. ALL PAINTING TO BE 3 COATS.
- 12. SPLASH APRON OF 600MM ALONG THE PERIMETER OF BUILDING.
- 13. SAMPLES OF FITTINGS, MATERIALS ETC. TO BE PRODUCED & APPROVE
- 14. ALL WINDOWS TO HAVE P.C. CILLS, BUILT IN REINFORCED CONCRETE PELMET BOXES & TIMBER INTERNAL WINDOW CILLS & SKIRTINGS.
- 15. FIRE FIGHTING EQUIPMENT TO BE PROVIDED AND INSTALLED BY BUILDING FIRE CONSULTANTS WHERE SHOWN ON PLAN.
- THE ENGINEER SHALL NOT ACCEPT ANY LIABILITY FOR WORKS WHICH HE HAS NOT BEEN EXPRESSLY INSTRUCTED TO SUPERVISE IN WRITING AND HAS ACCEPTED TO PROCEED IN WRITING, OR FOR ANY OMISSIONS OR DEVIATIONS FROM HIS DRAWINGS/TECHNICAL SPECIFICATIONS.
- OR DEVIATIONS FROM HIS DRAWINGS/TECHNICAL SPECIFICATIONS. NOR SHALL HE TAKE RESPONSIBILITY FOR WORKS HANDLED BY OTHER NOMINATED CONSULTANTS OR CONTRACTORS D.P.C DENOTES ONE LAYER OF BITUMINOUS FELT TO BE PROVIDED UNDER ALL WALLS AT LEAST 150MM ABOVE
- GROUND LEVEL.

  CONTRACTORS MUST VERIFY ALL DIMENSIONS AND LEVELS ON SITE BEFORE COMMENCEMENT OF WORKS, ANY DISCREPANCIES MUST BE REPORTED TO THE ENGINEER/CONSULTANT BEFORE ANY WORKS

- EXECUTION

  19. ALL LEVELS SHOWN AT FINISHED LEVELS UNLESS
  OTHERWISE STATED.

  20. ALL SURFACE BEDS TO BE CAST ON WELL-COMPACTED &
  WELL-CONSOLIDATED MURRUM OR SAND INFILL WHERE APPLICABLY STATED
- APPLICABLY STATED.

  21. ALL CONSTRUCTION WORKS TO COMPLY WITH THE LATEST B.S STANDARD CODES OF PRACTICE, LOCAL AUTHORITY BY-LAWS AND FIRE REGULATIONS.

  22. DEPTH OF FOUNDATION TRENCHES TO BE A MINIMUM OF
- 750MM BELOW REDUCED GROUND LEVEL.

### Client:



# Project:


# COMMUNITY TAP STAND STANDARD DESIGN FOR KAABONG DISTRICT

# Drawing Title

#### Reservoir

Beam & Slab Section Details

Scale:	Designed:	
AS SHOWN	Drawn:	PLA
Date:	Checked:	Infrastructure Team
February/2025	Approved:	JSK
Drg No: GKA []11		

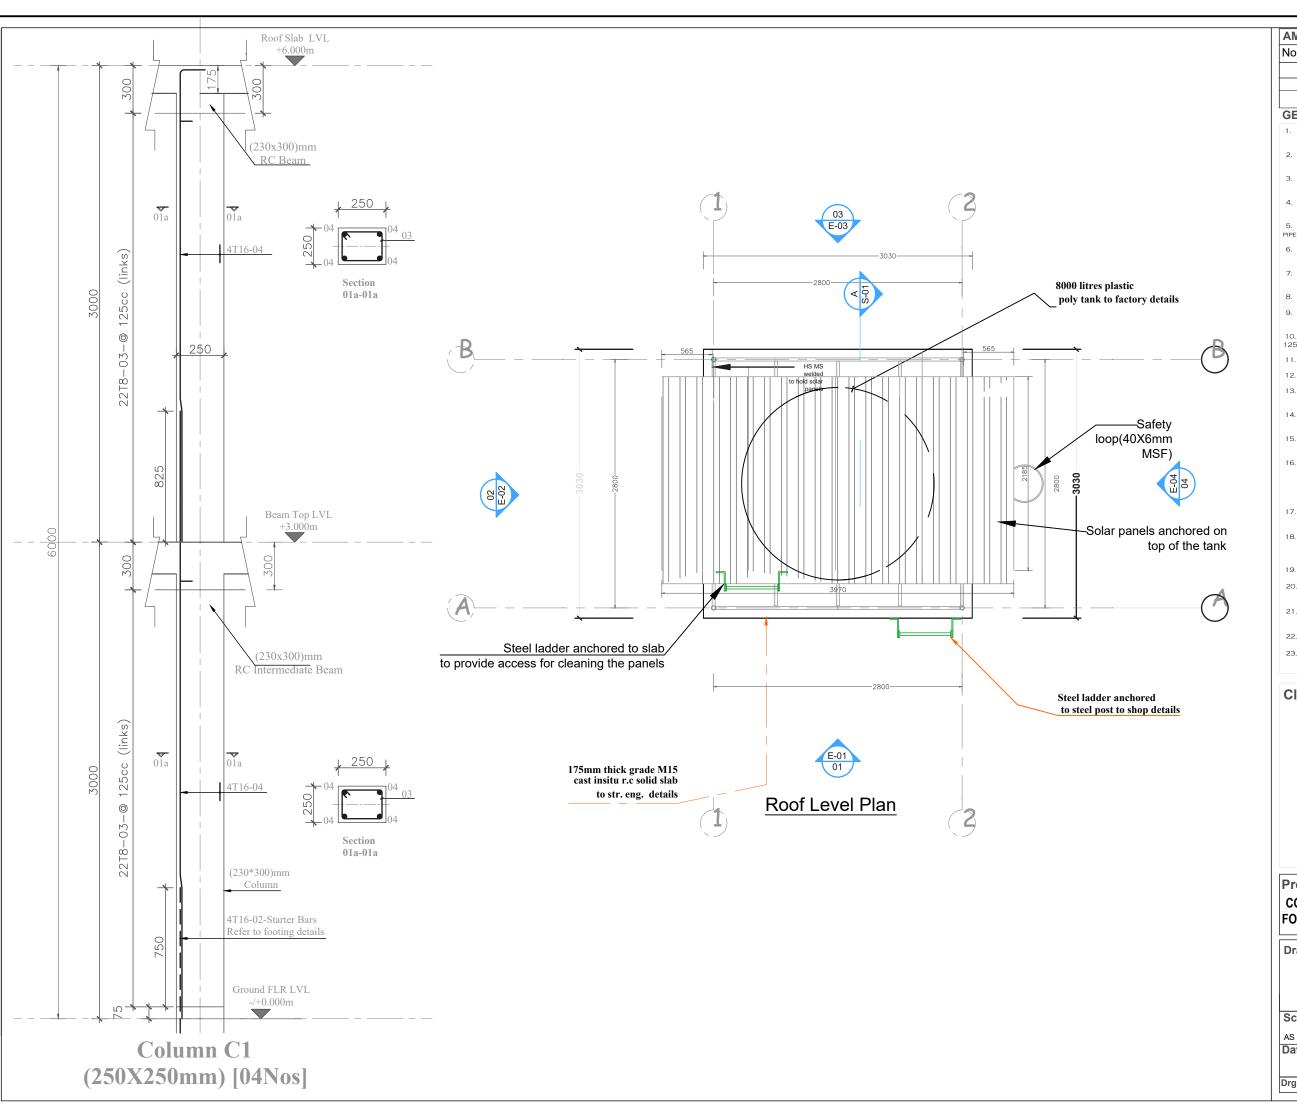

**AMENDMENTS** No Date Revision

#### **GENERAL NOTES**;

- ALL DIMENSIONS TO BE CHECKED ON SITE, WRITTEN DIMENSIONS TO BE FOLLOWED IN PREFERENCE TO SCALED DIMENSIONS
- ALL WALLS LESS THAN 200MM THICK TO BE REINFORCED WITH HOOP IRON AT EVERY ALTERNATE COURSE.
- ALL REINFORCED CONCRETE WORK IS TO BE IN ACCORDANCE WITH STRUCTURAL ENGINEER'S DETAILS.
- ALL SANITARY WORK TO BE IN ACCORDANCE WITH M.O.H RULES AND REGULATIONS.
- WHERE DRAIN PASSES UNDER BUILDING OR DRIVEWAY AREA. PIPE TO BE OF CAST IRON OR ENCASED IN 150MM CONCRETE.
- ALL WASTE PIPES AND SOIL PIPES ARE TO BE IN DUCTS AND THE BENDS TO HAVE ALL CLEANING EYES ACCESSIBLE FROM OUTSIDE.
- ALL WINDOWS AND EXTERNAL GLAZED DOORS ON GROUND FLOOR TO
- HAVE BURGLAR PROOFING TO DETAILS.
- ALL INTERNAL PLASTER TO BE TWO COATS STEEL FLOAT FINISHED.
- ALL MANHOLES WITHIN BUILDING AREA, DRIVEWAY AND PARKING TO HAVE HEAVY DUTY AIR TIGHT COVERS AND DOUBLE SEALED.
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  22. DEPTH OF FOUNDATION TRENCHES TO BE A MINIMUM OF
- 750MM BELOW REDUCED GROUND LEVEL.
- 23. ALL PIPES AND SERVICES TO BE AT A MINIMUM OF 450MM BELOW REDUCED GROUND LEVEL

### Client:



# Project:


# **COMMUNITY TAP STAND STANDARD DESIGN** FOR KAABONG DISTRICT

# Drawing Title

#### Reservoir

Column Details and Roof Plan

Scale:	Designed:	
AS SHOWN	Drawn:	PLA
Date:	Checked:	Infrastructure Team
February/2025	Approved:	JSK
Drg No: GKA [112		

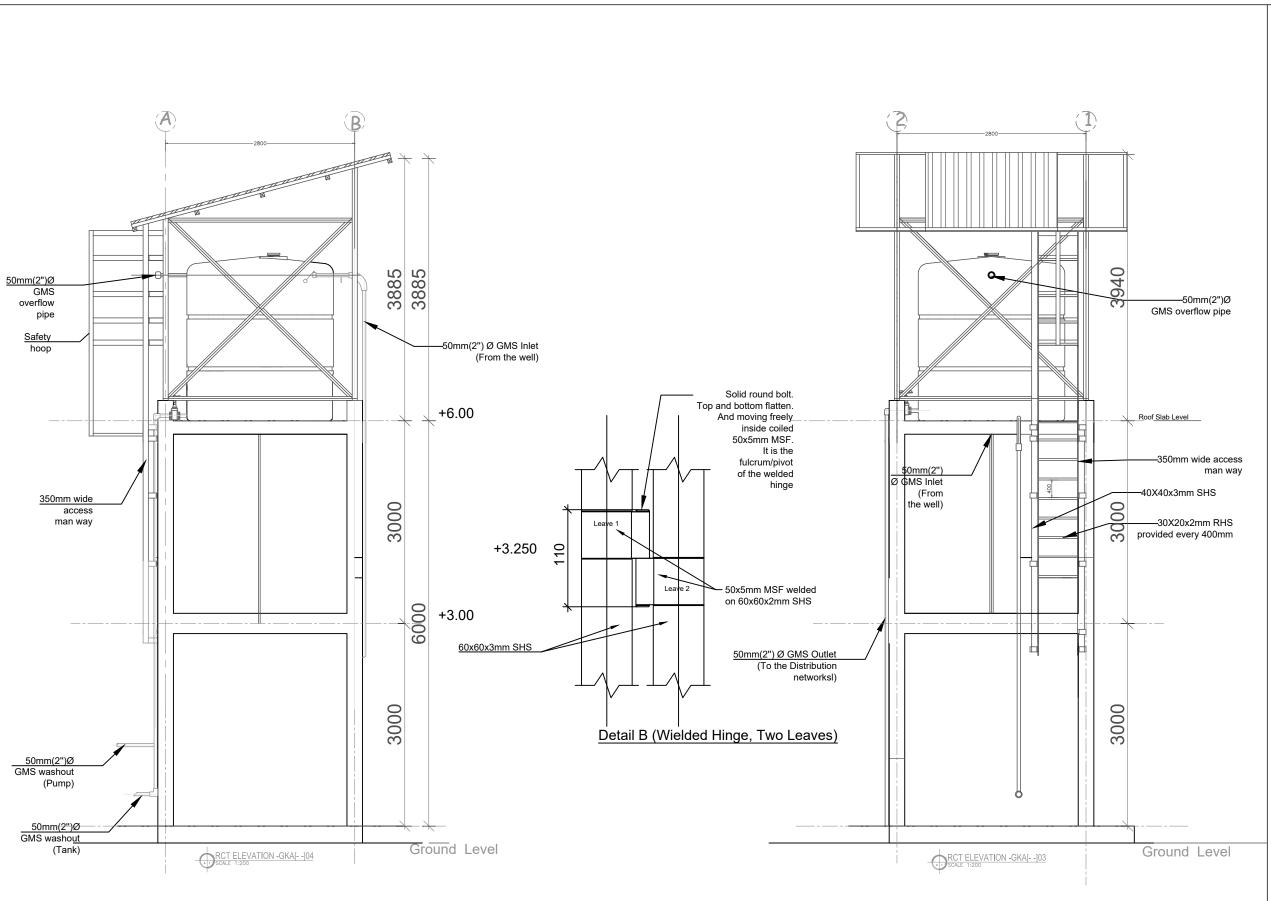

AMENDMENTS		
No	Date	Revision

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- 4. ALL SANITARY WORK TO BE IN ACCORDANCE WITH M.O.H RULES AND REGULATIONS.
- 5. WHERE DRAIN PASSES UNDER BUILDING OR DRIVEWAY AREA. PIPE TO BE OF CAST IRON OR ENCASED IN 150MM CONCRETE.
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  17. D.P.C DENOTES ONE LAYER OF BITUMINOUS FELT TO BE PROVIDED UNDER ALL WALLS AT LEAST 150MM ABOVE GROUND LEVEL.
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### Client:



# Project:


# COMMUNITY TAP STAND STANDARD DESIGN FOR KAABONG DISTRICT

Drawing Title

### Reservoir

RCT Elevations

Scale:	Designed:	
AS SHOWN	Drawn:	PLA
Date:	Checked:	Infrastructure Team
February/2025	Approved:	JSK
Drg No: RCT-GKA []	103 & 04	

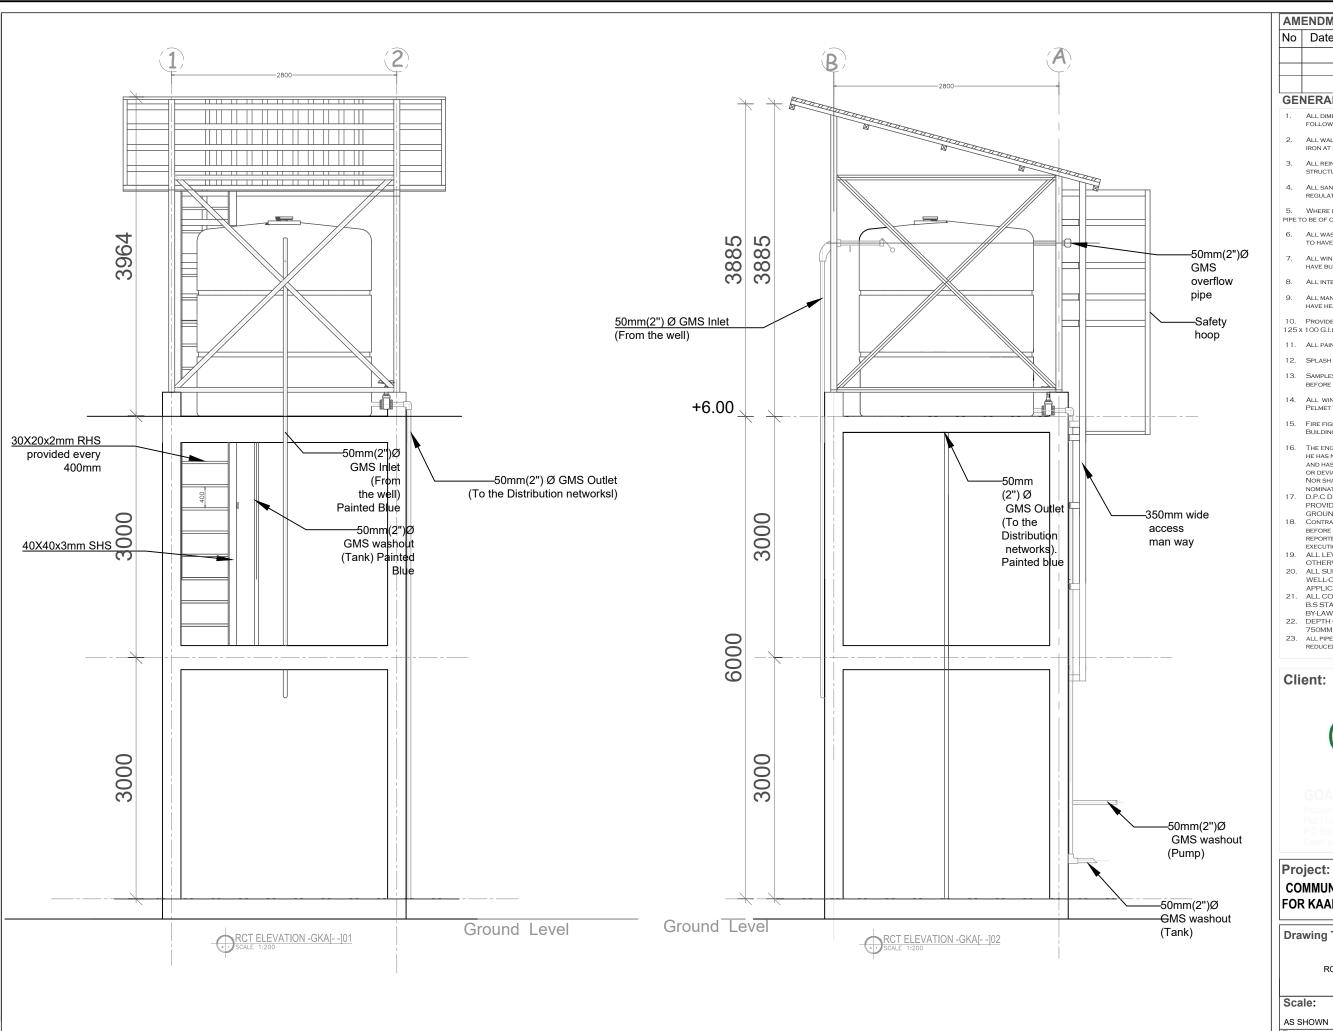

AM	AMENDMENTS		
No	Date	Revision	

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- EXECUTION

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- 750MM BELOW REDUCED GROUND LEVEL.
- 23. ALL PIPES AND SERVICES TO BE AT A MINIMUM OF 450MM BELOW REDUCED GROUND LEVEL

### Client:




# **COMMUNITY TAP STAND STANDARD DESIGN** FOR KAABONG DISTRICT

# Drawing Title

#### Reservoir

RCT Elevations

	Scale: AS SHOWN  Date: February/2025		
D	Scale:	Designed:	
		Drawn:	PLA
	Date:	Checked:	Infrastructure Team
	February/2025	Approved:	JSK
	Drg No: RCT-GKA [	101 & 02	•

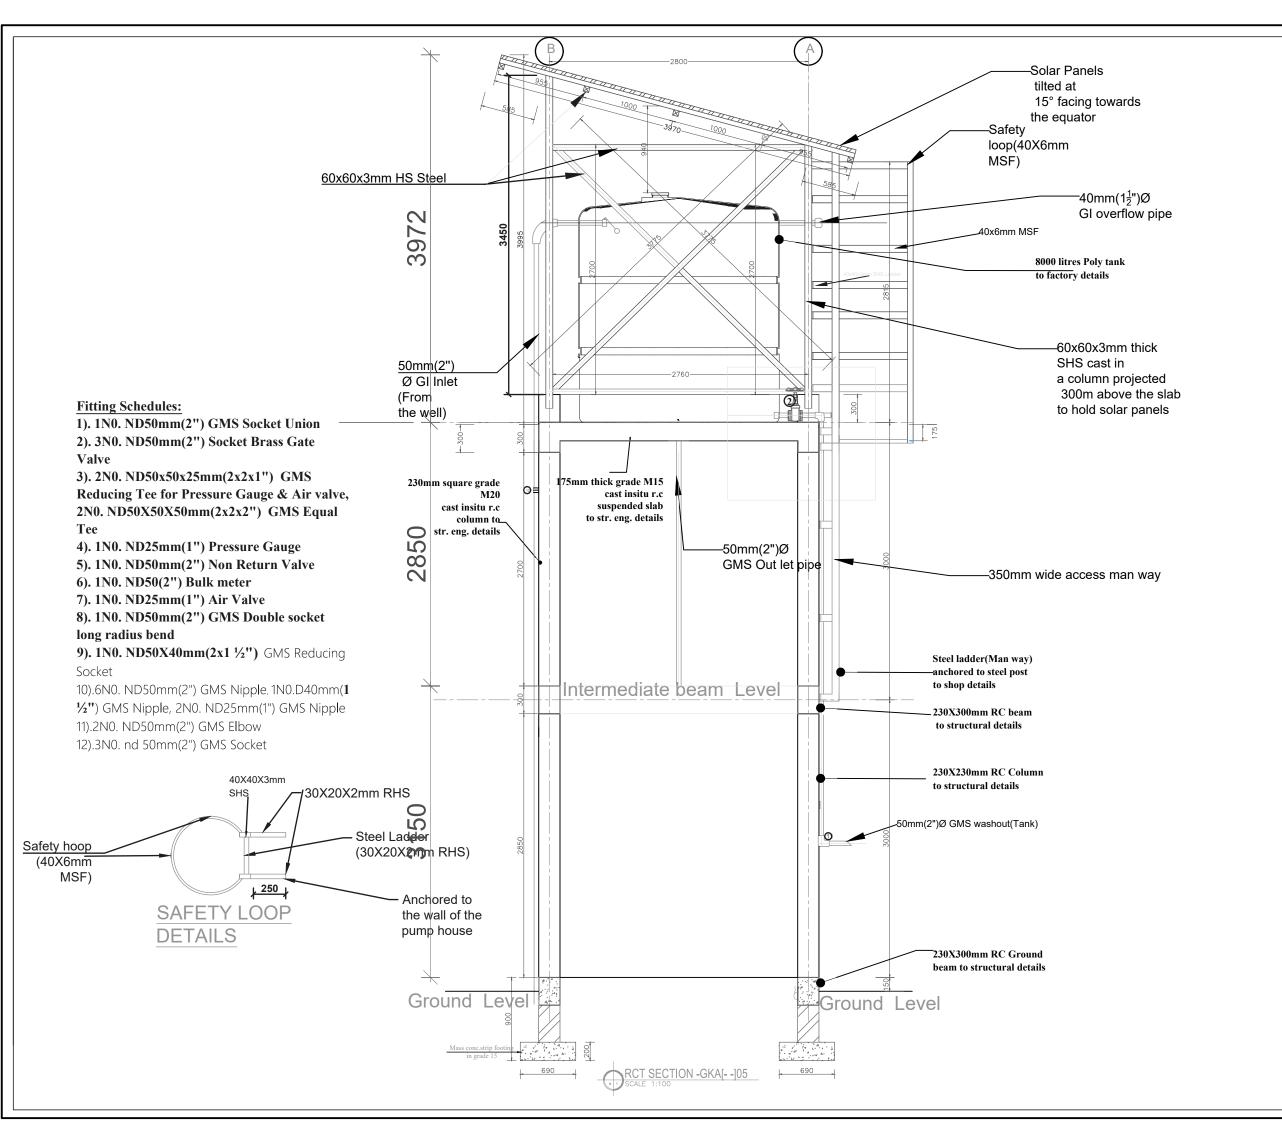

AM	AMENDMENTS		
No	Date	Revision	

- ALL DIMENSIONS TO BE CHECKED ON SITE, WRITTEN DIMENSIONS TO BE
- ALL WALLS LESS THAN 200MM THICK TO BE REINFORCED WITH HOOF
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- WHERE DRAIN PASSES UNDER BUILDING OR DRIVEWAY AREA. PIPE TO BE OF CAST IRON OR ENCASED IN 150MM CONCRETE

- ALL WINDOWS AND EXTERNAL GLAZED DOORS ON GROUND FLOOR TO HAVE BURGLAR PROOFING TO DETAILS
- ALL INTERNAL PLASTER TO BE TWO COATS STEEL FLOAT FINISHED.
- ALL MANHOLES WITHIN BUILDING AREA, DRIVEWAY AND PARKING TO HAVE HEAVY DUTY AIR TIGHT COVERS AND DOUBLE SEALED.
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  22. DEPTH OF FOUNDATION TRENCHES TO BE A MINIMUM OF
- 750MM BELOW REDUCED GROUND LEVEL.

### Client:



# Project:


# COMMUNITY TAP STAND STANDARD DESIGN FOR KAABONG DISTRICT

# Drawing Title

#### Reservoir

RCT Sections

Scale:	Designed:	
AS SHOWN	Drawn:	PLA
Date:	Checked:	Infrastructure Team
February/2025	Approved:	JSK
Drg No: RCT-GKA [	1.05	

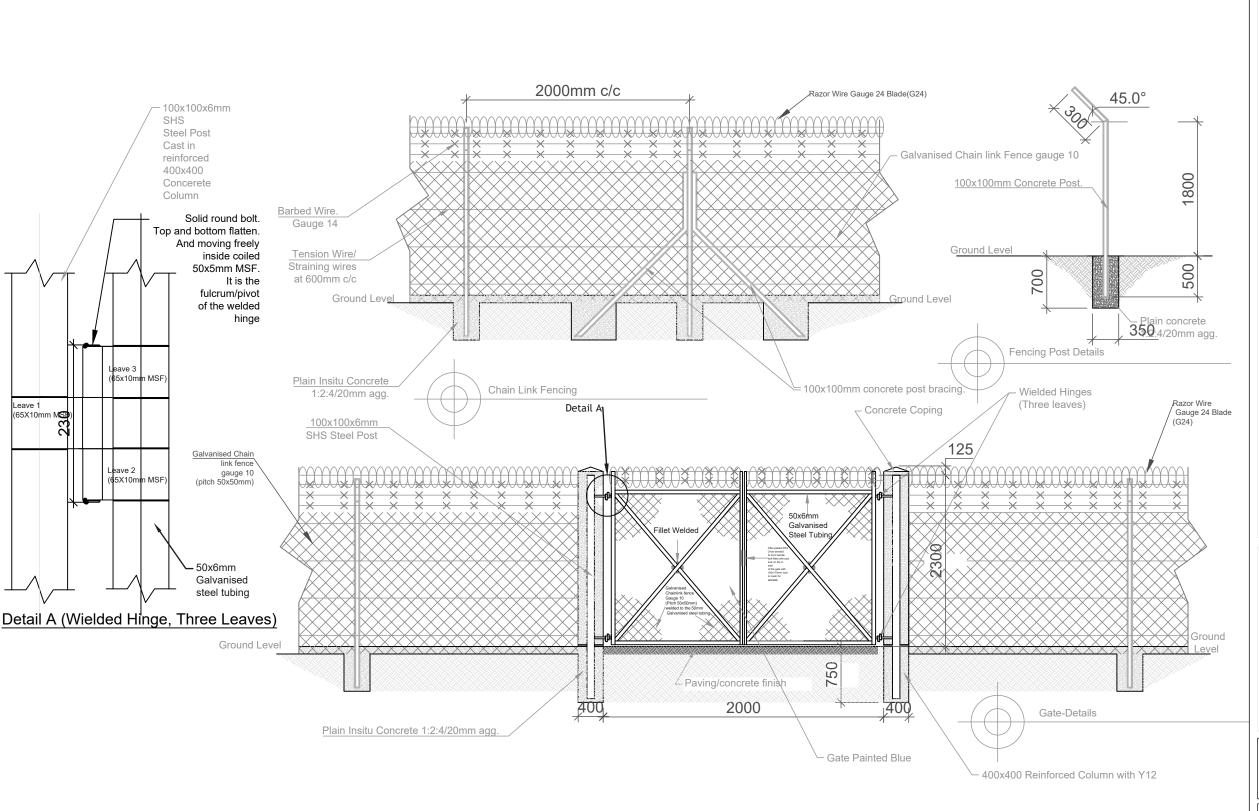

AM	AMENDMENTS		
No	Date	Revision	

- ALL DIMENSIONS TO BE CHECKED ON SITE, WRITTEN DIMENSIONS TO BE FOLLOWED IN PREFERENCE TO SCALED DIMENSION:
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- 23. ALL PIPES AND SERVICES TO BE AT A MINIMUM OF 450MM BELOW REDUCED GROUND LEVEL

### Client:



# Project:


# COMMUNITY TAP STAND STANDARD DESIGN FOR KAABONG DISTRICT

# Drawing Title

#### Intake & Reservoir

Chainlink Fence Details

Scale:	Designed:		
AS SHOWN	Drawn:	PLA	
Date:	Checked:	Infrastructure Team	
February/2025	Approved:	JSK	
Drg No: GKA [115			

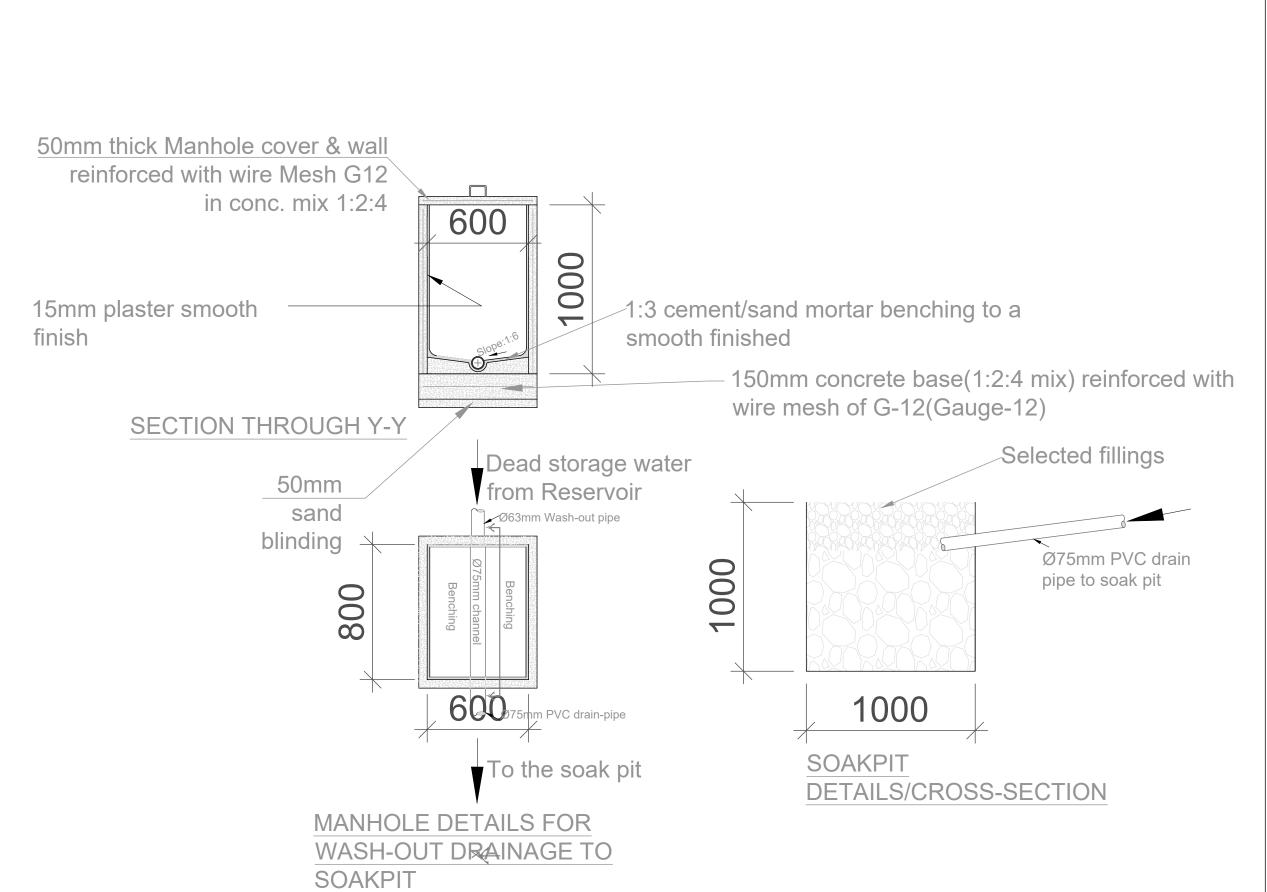

AM	AMENDMENTS		
No	Date	Revision	

- ALL DIMENSIONS TO BE CHECKED ON SITE, WRITTEN DIMENSIONS TO BE
- ALL WALLS LESS THAN 200MM THICK TO BE REINFORCED WITH HOO
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- 11. ALL PAINTING TO BE 3 COATS.

HAVE BURGLAR PROOFING TO DETAILS

- 12. SPLASH APRON OF 600MM ALONG THE PERIMETER OF BUILDING
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### Client:



# Project:


# **COMMUNITY TAP STAND STANDARD DESIGN** FOR KAABONG DISTRICT

### Drawing Title

#### **Transmission & Distribution**

Manhole Details

Scale:	Designed:		
AS SHOWN	Drawn:	PLA	
Date:	Checked:	Infrastructure Team	
February/2025	Approved:	JSK	
Drg No: GKA [116			

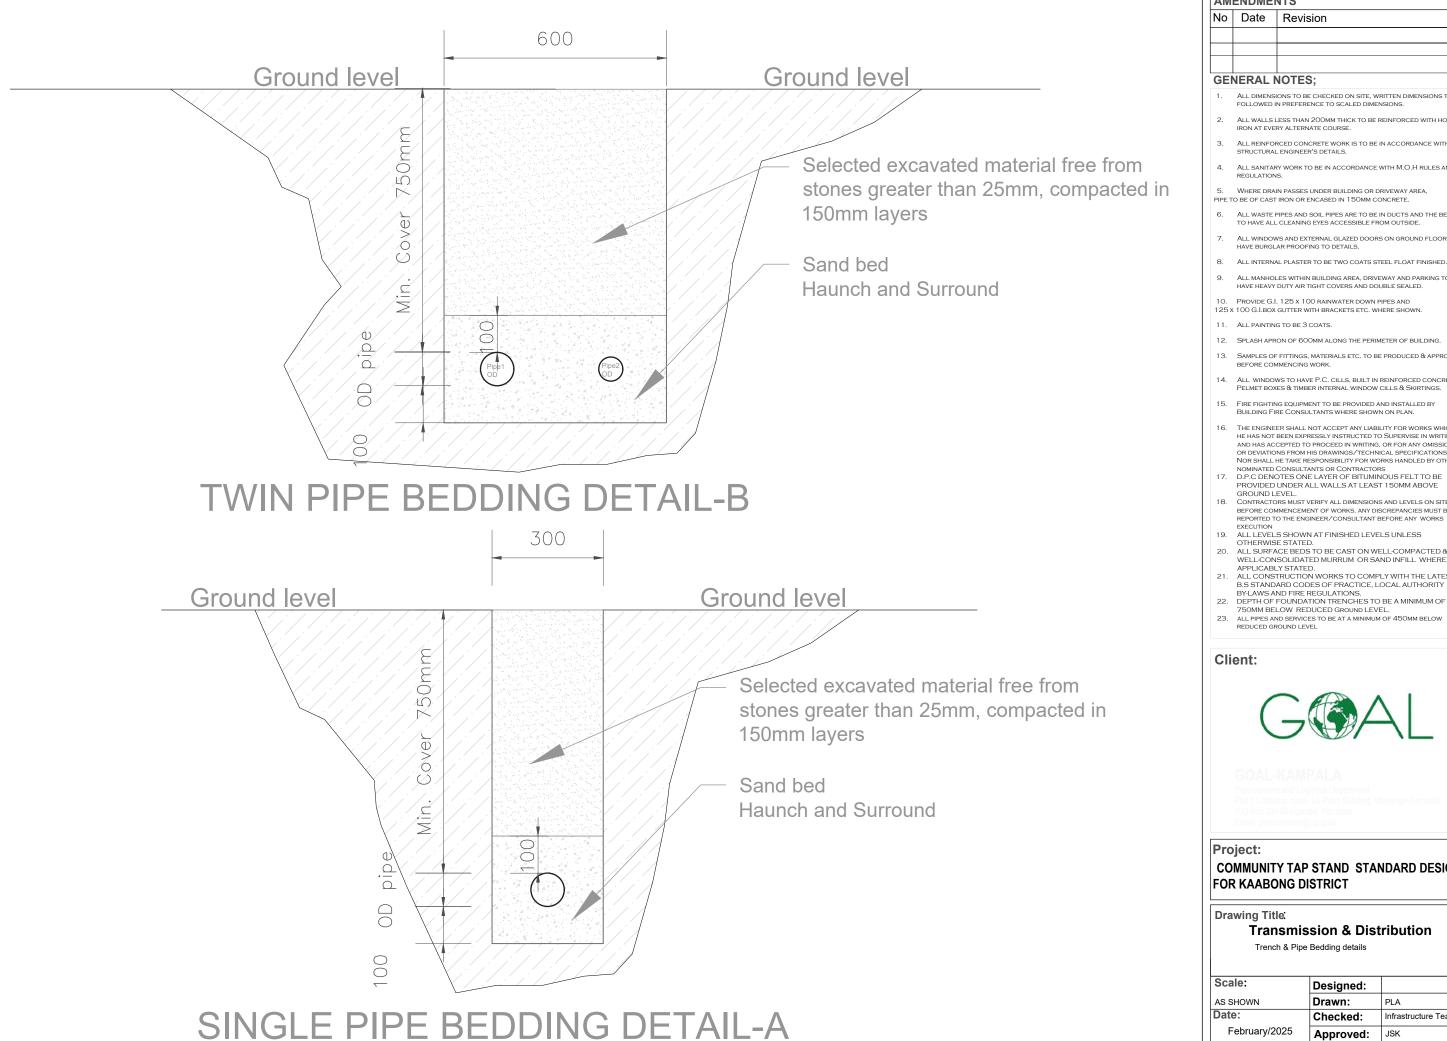

	AMENDMENTS		
1	No	Date	Revision

- ALL DIMENSIONS TO BE CHECKED ON SITE, WRITTEN DIMENSIONS TO BE
- ALL WALLS LESS THAN 200MM THICK TO BE REINFORCED WITH HOO
- ALL REINFORCED CONCRETE WORK IS TO BE IN ACCORDANCE WITH STRUCTURAL ENGINEER'S DETAILS.
- 4. ALL SANITARY WORK TO BE IN ACCORDANCE WITH M.O.H RULES AND
- 5 WHERE DRAIN PASSES LINDER BUILDING OR DRIVEWAY AREA
- ALL WASTE PIPES AND SOIL PIPES ARE TO BE IN DUCTS AND THE BENE TO HAVE ALL CLEANING EYES ACCESSIBLE FROM OUTSIDE. ALL WINDOWS AND EXTERNAL GLAZED DOORS ON GROUND FLOOR TO
- HAVE BURGLAR PROOFING TO DETAILS.
- ALL MANHOLES WITHIN BUILDING AREA, DRIVEWAY AND PARKING TO HAVE HEAVY DUTY AIR TIGHT COVERS AND DOUBLE SEALED.
- PROVIDE G.I. 125 x 100 RAINWATER DOWN PIPES AND 125 x 100 G.I.BOX GUTTER WITH BRACKETS ETC. WHERE SHOWN.
- 11. ALL PAINTING TO BE 3 COATS.
- 12. SPLASH APRON OF 600MM ALONG THE PERIMETER OF BUILDING
- 13. SAMPLES OF FITTINGS, MATERIALS ETC. TO BE PRODUCED & APP
- 14. ALL WINDOWS TO HAVE P.C. CILLS, BUILT IN REINFORCED CONCRETE PELMET BOXES & TIMBER INTERNAL WINDOW CILLS & SKIRTINGS
- 15. FIRE FIGHTING EQUIPMENT TO BE PROVIDED AND INSTALLED BY BUILDING FIRE CONSULTANTS WHERE SHOWN ON PLAN
- 16. THE ENGINEER SHALL NOT ACCEPT ANY LIABILITY FOR WORKS WHICH HE HAS NOT BEEN EXPRESSLY INSTRUCTED TO SUPERVISE IN WRITING AND HAS ACCEPTED TO PROCEED IN WRITING, OR FOR ANY OMISSIONS OR DEVIATIONS FROM HIS DRAWINGS/TECHNICAL SPECIFICATIONS. NOR SHALL HE TAKE RESPONSIBILITY FOR WORKS HANDLED BY OTHER NOMINATED CONSULTANTS OR CONTRACTORS

  17. D.P.C DENOTES ONE LAYER OF BITUMINOUS FELT TO BE
- PROVIDED UNDER ALL WALLS AT LEAST 150MM ABOVE GROUND LEVEL
- 18. CONTRACTORS MUST VERIFY ALL DIMENSIONS AND LEVELS ON SITE BEFORE COMMENCEMENT OF WORKS. ANY DISCREPANCIES MUST BE REPORTED TO THE ENGINEER/CONSULTANT BEFORE ANY WORKS
- EXECUTION

  19. ALL LEVELS SHOWN AT FINISHED LEVELS UNLESS
  OTHERWISE STATED.

  20. ALL SURFACE BEDS TO BE CAST ON WELL-COMPACTED &
  WELL-CONSOLIDATED MURRUM OR SAND INFILL WHERE
- APPLICABLY STATED APPLICABLY STATED.

  21. ALL CONSTRUCTION WORKS TO COMPLY WITH THE LATEST B.S STANDARD CODES OF PRACTICE, LOCAL AUTHORITY BY-LAWS AND FIRE REGULATIONS.

  22. DEPTH OF FOUNDATION TRENCHES TO BE A MINIMUM OF
  - 750MM BELOW REDUCED GROUND LEVEL.
- 23. ALL PIPES AND SERVICES TO BE AT A MINIMUM OF 450MM BELOW REDUCED GROUND LEVEL

### Client:



# Project:


# **COMMUNITY TAP STAND STANDARD DESIGN** FOR KAABONG DISTRICT

# Drawing Title

#### **Transmission & Distribution**

Trench & Pipe Bedding details

Scale:	Designed:		
AS SHOWN	Drawn:	PLA	
Date:	Checked:	Infrastructure Team	
February/2025	Approved:	JSK	
Drg No: GKA []17			

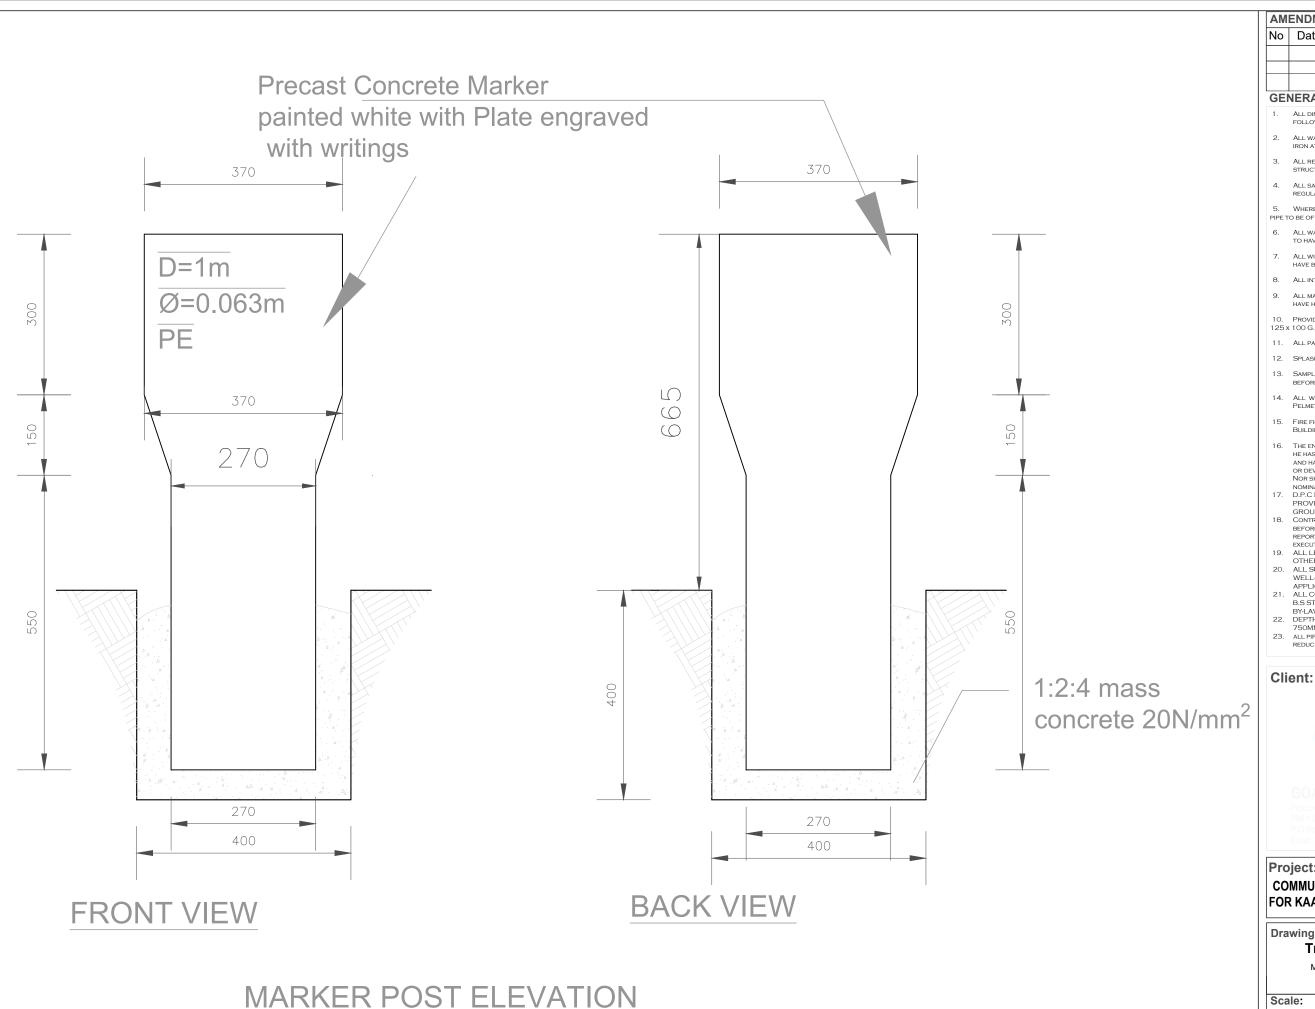

**AMENDMENTS** No Date Revision

#### **GENERAL NOTES**;

- 1. ALL DIMENSIONS TO BE CHECKED ON SITE, WRITTEN DIMENSIONS TO BE FOLLOWED IN PREFERENCE TO SCALED DIMENSIONS
  - ALL WALLS LESS THAN 200MM THICK TO BE REINFORCED WITH HOOF
- ALL REINFORCED CONCRETE WORK IS TO BE IN ACCORDANCE WITH STRUCTURAL ENGINEER'S DETAILS.
- 4. ALL SANITARY WORK TO BE IN ACCORDANCE WITH M.O.H RULES AND
- 5. WHERE DRAIN PASSES UNDER BUILDING OR DRIVEWAY AREA. PIPE TO BE OF CAST IRON OR ENCASED IN 150MM CONCRETE.
- ALL WASTE PIPES AND SOIL PIPES ARE TO BE IN DUCTS AND THE BEND TO HAVE ALL CLEANING EYES ACCESSIBLE FROM OUTSIDE.
- ALL WINDOWS AND EXTERNAL GLAZED DOORS ON GROUND FLOOR TO HAVE BURGLAR PROOFING TO DETAILS.
- ALL INTERNAL PLASTER TO BE TWO COATS STEEL FLOAT FINISHED.
- PROVIDE G.I. 125 x 100 RAINWATER DOWN PIPES AND 125 x 100 G.I.BOX GUTTER WITH BRACKETS ETC. WHERE SHOWN.
- 11. ALL PAINTING TO BE 3 COATS.
- 12. SPLASH APRON OF 600MM ALONG THE PERIMETER OF BUILDING
- 13. SAMPLES OF FITTINGS, MATERIALS ETC. TO BE PRODUCED & APPR
- 14. ALL WINDOWS TO HAVE P.C. CILLS, BUILT IN REINFORCED CONCRETE PELMET BOXES & TIMBER INTERNAL WINDOW CILLS & SKIRTINGS.
- 15. FIRE FIGHTING EQUIPMENT TO BE PROVIDED AND INSTALLED BY BUILDING FIRE CONSULTANTS WHERE SHOWN ON PLAN.
- 16. THE ENGINEER SHALL NOT ACCEPT ANY LIABILITY FOR WORKS WHICH HE HAS NOT BEEN EXPRESSLY INSTRUCTED TO SUPERVISE IN WRITING AND HAS ACCEPTED TO PROCEED IN WRITING, OR FOR ANY OMISSIONS OR DEVIATIONS FROM HIS DRAWINGS/TECHNICAL SPECIFICATIONS. NOR SHALL HE TAKE RESPONSIBILITY FOR WORKS HANDLED BY OTHER NOMINATED CONSULTANTS OR CONTRACTORS

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# Project:

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Marker Post details

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AS SHOWN	Drawn:	PLA
Date:	Checked:	Infrastructure Team
February/2025	Approved:	JSK
Drg No: GKA [118		